

DEPARTMENT OF REGULATORY AND ECONOMIC RESOURCES (RER) BOARD AND CODE ADMINISTRATION DIVISION

MIAMI-DADE COUNTY PRODUCT CONTROL SECTION 11805 SW 26 Street, Room 208 T (786) 315-2590 F (786) 315-2599

www.miamidade.gov/economy

NOTICE OF ACCEPTANCE (NOA)

Weather Shield Manufacturing, Inc. One Weather Shield Plaza (P.O. Box 309) Medford, WI 54451–0309

Scope:

This NOA is being issued under the applicable rules and regulations governing the use of construction materials. The documentation submitted has been reviewed and accepted by Miami-Dade County RER - Product Control Section to be used in Miami Dade County and other areas where allowed by the Authority Having Jurisdiction (AHJ).

This NOA shall not be valid after the expiration date stated below. The Miami-Dade County Product Control Section (In Miami Dade County) and/or the AHJ (in areas other than Miami Dade County) reserve the right to have this product or material tested for quality assurance purposes. If this product or material fails to perform in the accepted manner, the manufacturer will incur the expense of such testing and the AHJ may immediately revoke, modify, or suspend the use of such product or material within their jurisdiction. RER reserves the right to revoke this acceptance, if it is determined by Miami-Dade County Product Control Section that this product or material fails to meet the requirements of the applicable building code.

This product is approved as described herein, and has been designed to comply with the Florida Building Code, including the High Velocity Hurricane Zone.

DESCRIPTION: Series "Legacy Lifeguard 10 Ft. Round Top" Outswing Aluminum Clad Wood French Door - L.M.L.

APPROVAL DOCUMENT: Drawing No. 1509, titled "Legacy Lifeguard French Outswing Round Top Door", sheets 1 through 4 of 4, dated 12/13/06, with revision B1 dated 11/01/11, prepared by W. W. Schaefer Engineering & Consulting, P.A., signed and sealed by Warren W. Schaefer, P.E., bearing the Miami-Dade County Product Control Revision stamp with the Notice of Acceptance number and expiration date by the Miami-Dade County Product Control Section.

MISSILE IMPACT RATING: Large and Small Missile Impact Resistant, LIMITATIONS:

- 1. Windows and ADA Threshold are NOT part of this approval.
- 2. Nail Fin anchors are part of frame shear screws and NOT an Alternate Option.
- 3. Maximum Design Pressure Rating of ± 60 psf for doors greater than 71¼" (Width) by 99" (Height).

LABELING: Each unit shall bear a permanent label with the manufacturer's name or logo, city, state, model/series, and following statement: "Miami-Dade County Product Control Approved", unless otherwise noted herein.

RENEWAL of this NOA shall be considered after a renewal application has been filed and there has been no change in the applicable building code negatively affecting the performance of this product.

TERMINATION of this NOA will occur after the expiration date or if there has been a revision or change in the materials, use, and/or manufacture of the product or process. Misuse of this NOA as an endorsement of any product, for sales, advertising or any other purposes shall automatically terminate this NOA. Failure to comply with any section of this NOA shall be cause for termination and removal of NOA.

ADVERTISEMENT: The NOA number preceded by the words Miami-Dade County, Florida, and followed by the expiration date may be displayed in advertising literature. If any portion of the NOA is displayed, then it shall be done in its entirety.

INSPECTION: A copy of this entire NOA shall be provided to the user by the manufacturer or its distributors and shall be available for inspection at the job site at the request of the Building Official.

This NOA revises NOA# 12-0710.02 and consists of this page 1 and evidence pages E-1 and E-2, as well as approval document mentioned above.

The submitted documentation was reviewed by Manuel Perez, P.E.

(MIAMIDADE COUNTY)
APPROYED

76/10/14

NOA No. 14-0424.15 Expiration Date: April 26, 2017 Approval Date: June 19, 2014

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Weather Shield Manufacturing, Inc.

NOTICE OF ACCEPTANCE: EVIDENCE SUBMITTED

A. DRAWINGS

- 1. Manufacturer's die drawings and sections.
- 2. Drawing No. 1509, titled "Legacy Lifeguard French Outswing Round Top Door", sheets 1 through 4 of 4, dated 12/13/06, with revision B1 dated 11/01/11, prepared by W. W. Schaefer Engineering & Consulting, P.A., signed and sealed by Warren W. Schaefer, P.E.

(Submitted under NOA No. 11-1128.03)

B. TESTS

- 1. Test reports on: 1) Air Infiltration Test, per FBC, TAS 202–94
 - 2) Uniform Static Air Pressure Test, Loading per FBC TAS 202–94
 - 3) Water Resistance Test, per FBC, TAS 202-94
 - 4) Large Missile Impact Test per FBC, TAS 201–94
 - 5) Cyclic Wind Pressure Loading per FBC, TAS 203-94

along with marked-up drawings and installation diagram of an outswing French door, prepared by Stork Twin City Testing Corporation, Test Report No. **TCTC-WI09003** dated 03/04/09, signed and sealed by Thomas Allan Kolden, P.E.

(Submitted under NOA No. 09-0929.07)

- 2. Test reports on: 1) Large Missile Impact Test per FBC, TAS 201–94
 - 2) Uniform Static Air Pressure Test, Loading per FBC TAS 202-94
 - 3) Water Resistance Test, per FBC, TAS 202-94
 - 4) Large Missile Impact Test per FBC, TAS 201–94
 - 5) Cyclic Wind Pressure Loading per FBC, TAS 203-94

along with marked-up drawings and installation diagram of an outswing French door, prepared by Stork Twin City Testing Corporation, Test Report No. **TCTC-WI05008**, dated 01/09/2006, signed and sealed by Thomas Allan Kolden, P. E.

(Submitted under NOA No. 07-0208,10)

C. CALCULATIONS

- 1. Anchor verification calculations and structural analysis, complying with **FBC–2010**, dated 02/01/07 and updated on 11/02/11 prepared by W. W. Schaefer Engineering & Consulting, P.A., signed and sealed by Warren W. Schaefer, P.E. (Submitted under NOA No. 11-1128.03)
- 2. Glazing complies with ASTM E1300-04

D. QUALITY ASSURANCE

1. Miami-Dade Department of Regulatory and Economic Resources (RER)

Manuel Perez, P.E. Product Control Examiner NOA No. 14-0424.15

Expiration Date: April 26, 2017 Approval Date: June 19, 2014

Weather Shield Manufacturing, Inc.

NOTICE OF ACCEPTANCE: EVIDENCE SUBMITTED

E. MATERIAL CERTIFICATIONS

1. Notice of Acceptance No. 12–1231.10 issued to Eastman Chemical Company (MA) for their "Saflex Clear and Color Glass Interlayers" dated 03/28/13, expiring on 05/21/16.

F. STATEMENTS

- 1. Statement letter of conformance, complying with FBC-2010 and FBC 5th Edition (2014), dated April 10, 2014, signed and sealed by Warren W. Schaefer, P.E.
- 2. Statement letter of no financial interest and independence, dated 11/02/11, signed and sealed by Warren W. Schaefer, P.E. (Submitted under NOA No. 11–1128.03)
- 3. Laboratory compliance letter for Test Report No. TCTC-WI09003, issued by Stork Twin City Testing Corporation, dated March 04, 2009, signed and sealed by Thomas Allan Kolden, P.E.
 - (Submitted under NOA No. 09-0929.07)
- 4. Laboratory compliance letter for Test Report No. **TCTC-WI05008**, issued by Stork Twin City Testing Corporation, dated January 09, 2006, signed and sealed by Thomas Allan Kolden, P.E.

(Submitted under NOA No. 07-0208.10)

G. OTHERS

1. Notice of Acceptance No. 12-0710.02, issued to Weather Shield Manufacturing, Inc. for their Series "Legacy Lifeguard" 10'0" Aluminum Clad Outswing Wood Round Top French Door – L.M.I.", approved on 07/26/12 and expiring on 04/26/17.

Manuel Perez, P.E. Product Control Examiner NOA No. 14-0424.15

Expiration Date: April 26, 2017 Approval Date: June 19, 2014 THESE DOOR SYSTEMS HAVE BEEN TESTED, ANALYZED & APPROVED FOR DESIGN PRESSURES NOT TO EXCEED THOSE SHOWN IN THE "ALLOWABLE DESIGN PRESSURE TABLE(S).
 OPENINGS, BUCKING & BUCKING FASTENERS MUST BE PROPERLY DESIGNED & INSTALLED TO FRAME SHEAR SCREW WHERE-

TRANSFER WIND LOADS TO THE STRUCTURE.

3. ALL HARDWARE & FASTENERS SHALL BE IN ACCORDANCE WITH THESE DRAWINGS & SHALL NOT VARY UNLESS SPECIFICALLY MENTIONED ON THE DRAWINGS. SPECIFIED ANCHOR EMBED TO BASE MATERIAL SHALL BE BEYOND WALL FINISH OR STUCCO.

4. THE DETAILS & SPECIFICATIONS SHOWN HEREIN REPRESENT THE PRODUCTS TESTED & PROPOSED FOR WATER, AIR, IMPACT, CYCLIC & UNIFORM STATIC AIR PRESSURE TESTING IN CONFORMANCE WITH THE FLORIDA BUILDING CODE PROTOCALS TAS-201, 202 & 203 FOR LARGE MISSILE IMPACT DOORS. 5. THESE DOOR SYSTEMS HAVE BEEN DESIGNED IN ACCORDANCE WITH AND MEET THE

REQUIREMENTS OF THE FLORIDA BUILDING CODE (FBC) INCLUDING HIGH VELOCITY HURRICANE ZONES

6. IMPACT SHUTTERS ARE NOT REQUIRED WITH THESE DOORS.
7. ALL ANCHORS SECURING DOOR FRAME TO PRESSURE TREATED BUCKS OR WOOD FRAMING SHALL BE CAPABLE OF RESISTING CORROSION CAUSED BY THE PRESSURE TREATING CHEMICALS IN THE WOOD.

8. DETERMINE THE POSITIVE & NEGATIVE DESIGN LOADS TO USE WHEN REFERENCING THESE DOCUMENTS IN ACCORDANCE WITH THE GOVERNING CODE AND GOVERNING WIND VELOCITY. FOR WIND LOAD CALCULATIONS IN ACCORDANCE WITH THE FLORIDA BUILDING CODE, A DIRECTIONALITY FACTOR OF Kd = 0.85 MAY BE APPLIED PER THE ASCE 7 STANDARD.

9. NO INCREASE IN ALLOWABLE STRESS HAS BEEN USED IN THE CERTIFICATION OF THIS PRODUCT. WIND LOAD DURATION FACTOR Cd = 1.6 WAS USED FOR WOOD SCREW ANALYSIS ONLY. 10. MATERIALS, INCLUDING BUT NOT LIMITED TO STEEL SCREWS, THAT COME INTO CONTACT WITH OTHER DISSIMILAR MATERIALS SHALL MEET THE REQUIREMENTS OF FLORIDA BUILDING CODE CHAPTER

11. All WOOD MEMBERS OF DOORS THAT MAY POSSIBLY COME INTO CONTACT WITH MASONRY OR CONCRETE SUBSTRATES, ARE SUBJECT TO MOISTURE &/OR ARE SUBJECT TO THE OUTSIDE

WOOD SCREWS AT EACH HEAD CORNER AND 3 NO. 8 X 3" WOOD SCREWS AT EACH CORNER & SEALED

INSTALLATION CLIP (1 1/2" X 20 GA. X 11" LONG GALVINIZED STEEL). EACH PLATE IS FASTENED WITH 12

FRAME ANCHOR REQUIREMENTS TABLE				
OPENING TYPE (SUBSTRATE)	FRAME/CLIP/NAIL FIN TO OPENING FASTENER TYPE	MINIMUM EMBED	MINIMUM EDGE DIST.	
FRAME/HINGE/STRIKE SHEAR SCREWS				
2X_ WOOD FRAME OR BUCK (MIN. GR. 3 & G=0.55)	NO, 10 SMS OR WOOD SCREW	1 1/4"	3/4"	
MIN. 1/8" THK A36 STEEL	NO. 10 SELF TAP/DRILLING SCREW	FULL	1/2"	
MIN. 1/8" THK 6063-T5 ALUM.	NO. 10 SELF TAP/DRILLING SCREW	FULL	1/2"	
NAILING FIN				
2X_ WOOD FRAME OR BUCK (MIN. GR. 3 & G=0.55)	NO. 8 X 1 1/2" SMS	1 3/8"	1/2"	
MIN. 1/8" THK A36 STEEL	NO. 8 SELF TAP/DRILLING SCREW	FULL	1/2"	
MIN. 1/8" THK 6063-T5 ALUM.	NO. 8 SELF TAP/DRILLING SCREW	FULL	1/2"	
SILL SCREWS				
2X_ WOOD FRAME OR BUCK (MIN. GR. 3 & G=0.55)	NO. 10 SMS OR WOOD SCREW	1 1/4"	3/4"	
MIN. 1/8" THK A36 STEEL.	NO. 10 SELF TAP/DRILLING SCREW	FULL	1/2"	
MIN. 1/8" THK 6063-T5 ALUM.	NO. 10 SELF TAP/DRILLING SCREW	FULL	1/2"	
MIN. 2500 PSI CONCRETE	(1) 3/16" CONCRETE SCREW	1 1/2"	2"	
(1) CONCRETE SCREWS SHALL BE ELCO ULTRACONS, ITW RAMSET/RED HEAD TAPCONS.				

DOORS AZA PLATE FOR SCREW/NAIL REQUIREMENTS. DOOR ENVIRONMENT SHALL BE OF AN APPROVED DURABLE SPECIES OR BE TREATED IN AN APPROVED METHOD WITH AN APPROVED PRESERVATIVE PER FBC SECTION 2326. WINDOWS & R SHIELD PLA), WI 54451 (40B)(40A)— INACTIVE LOCK 42A)(42B) CORNER CONSTRUCTION SILL CORNERS: SIDE JAMBS ARE COPED & BUTTED TO SILL AND SECURED WITH 3 NO. 8 X 2 1/2" FH ACTIVE LOCK 5 SHIELD WIN WEATHER SH MEDFORD, WI 715-748-WITH A GASKET & DOW 1166 SILICONE SEALANT. ROUND Ċ HEAD FRAME RADIUS END JOINT: SIDE JAMB IS SQUARE CUT AND SECURED TO RADIUS JAMB WITH AN 7" MAX, O.C. <u>ا</u> (ARCHRAMERVERNICAL SIDES) as complying with the Florida NO. 6 X 5/8" SS FH WOOD SCREWS (6 EACH SIDE OF JOINT). FRAME B 2 $\binom{\mathbb{C}}{2}$ B 2 DOOR PANEL CORNERS: RAILS ARE BUTTED TO STILES & JOINED WITH 3/4" X 3" LONG WOOD DOWELS; 2 DOWELS PER EACH HEAD RAIL TO LOCK STILE CORNER, 4 DOWELS PER EACH HEAD RAIL TO HINGE STILE CORNER, AND 3 DOWELS PER EACH SILL RAIL TO STILE CORNER. ALL CORNERS ARE SILICONED ALONG THE ₩X. Building Code Building Code
Acceptance No 4-0474.
Expiration Date April 20, OUTSWING WEATHER ONE MAX. 103" 24 1/16" CLAD CORNERS: CLADDING IS MITER CUT & SECURED WITH A 1/4" BEAD OF SILICONE. MAX. D.L.O. Miami/Dade Product Control PRODUCT REVISED 23 ALLOWABLE DESIGN PRESSURE as complying with the Florida FRENCH O.C Building Cade +60/-70 PSF Acceptance No 11-1128,03 Expiration Date 64/26/2019 NESULTANTS

W. SCHAEFER ENGINEERING

CONSULTING, P.A. (CA 6809)

7480 150TH COURT NORTH
PALM BEACH GRODES, R. 33418
PALM BRONE: SSI-744-3476 LIFEGUARD Mismi Bade Product Control > 28-STRIKE PLATE HINGE SCREW INTO SUBSTRATE (2 PER HINGE). PRODUCT KENEWED LEGACY ad complying with the Florida SEE "FRAME ANCHOR 12-0119 102 Blitding Code REQUIREMENTS TABLE" ON Injuntion Date 04 126 2 THIS SHEET FOR SCREW REQUIREMENTS. STRIKE WONEER ATTE ર્કે≱ એ NOINEERX MAX. SEE SEE STANDING TO SEE 44135 2011 MAX. 6" MAX. \§ 3 STRIKE SCREWS INTO SUBSTRATE, SEE-SILL ANCHORS WHERE SHOWN. SEE "FRAME ANCHOR REQUIREMENTS TABLE" ON "FRAME ANCHOR REQUIREMENTS THIS SHEET FOR SCREW REQUIREMENTS. TABLE" ON THIS SHEET FOR SCREW REQUIREMENTS (4 AT MIDSPAN & 1 DRAWING NO. I REV. EXTERIOR ELEVATION AT EACH CORNER). В 1509 DOUBLE RADIUS OUTSWING DOOR SHEET NO. HILTI KWIK-CON II OR POWERS RAWL TAPPER (HARDENED STEEL OR S.S.), SCALE: 3/4" = 1'-0"OF

SHOWN. SEE "FRAME ANCHOR

SEE "CORNER-

CONSTRUCTION"

DESCRIPTION ON

THIS SHEET

O.C.)

REQUIREMENTS TABLE" ON THIS

SHEET FOR SCREW REQUIREMENTS.

(5 AT HEAD MIDSPAN & MAX. 12"

74 1/4" MAX. FRAME WIDTH

STRIKE

PLATE

INACTIVE

STRIKE

 $\binom{A}{2}$

THESE DRAWINGS ARE APPLICABLE ONLY TO THE PRODUC SPECIFIED. THEY MAY NOT BE USED FOR THE ASSEMBLY

THEY BE USED FOR RATIONAL AND/OR LOCAL APPROVAL OF ANY PRODUCT NOT PRODUCED BY THE MANUFACTURE

NAIL FIN ANCHORS WHERE

SHOWN. SEE "FRAME

ANCHOR REQUIREMENTS

TABLE" ON THIS SHEET

-3 STRIKE SCREWS INTO

REQUIREMENTS.

SUBSTRATE. SEE "FRAME

ANCHOR REQUIREMENTS TABLE"


ON THIS SHEET FOR SCREW


3" MAX, O.C. (AT FRAME RADIUS)

AND/OR INSTALLATION OF ANY OTHER PRODUCT NOR MAY

CHECKED BY: W.W.S.

12/13/08

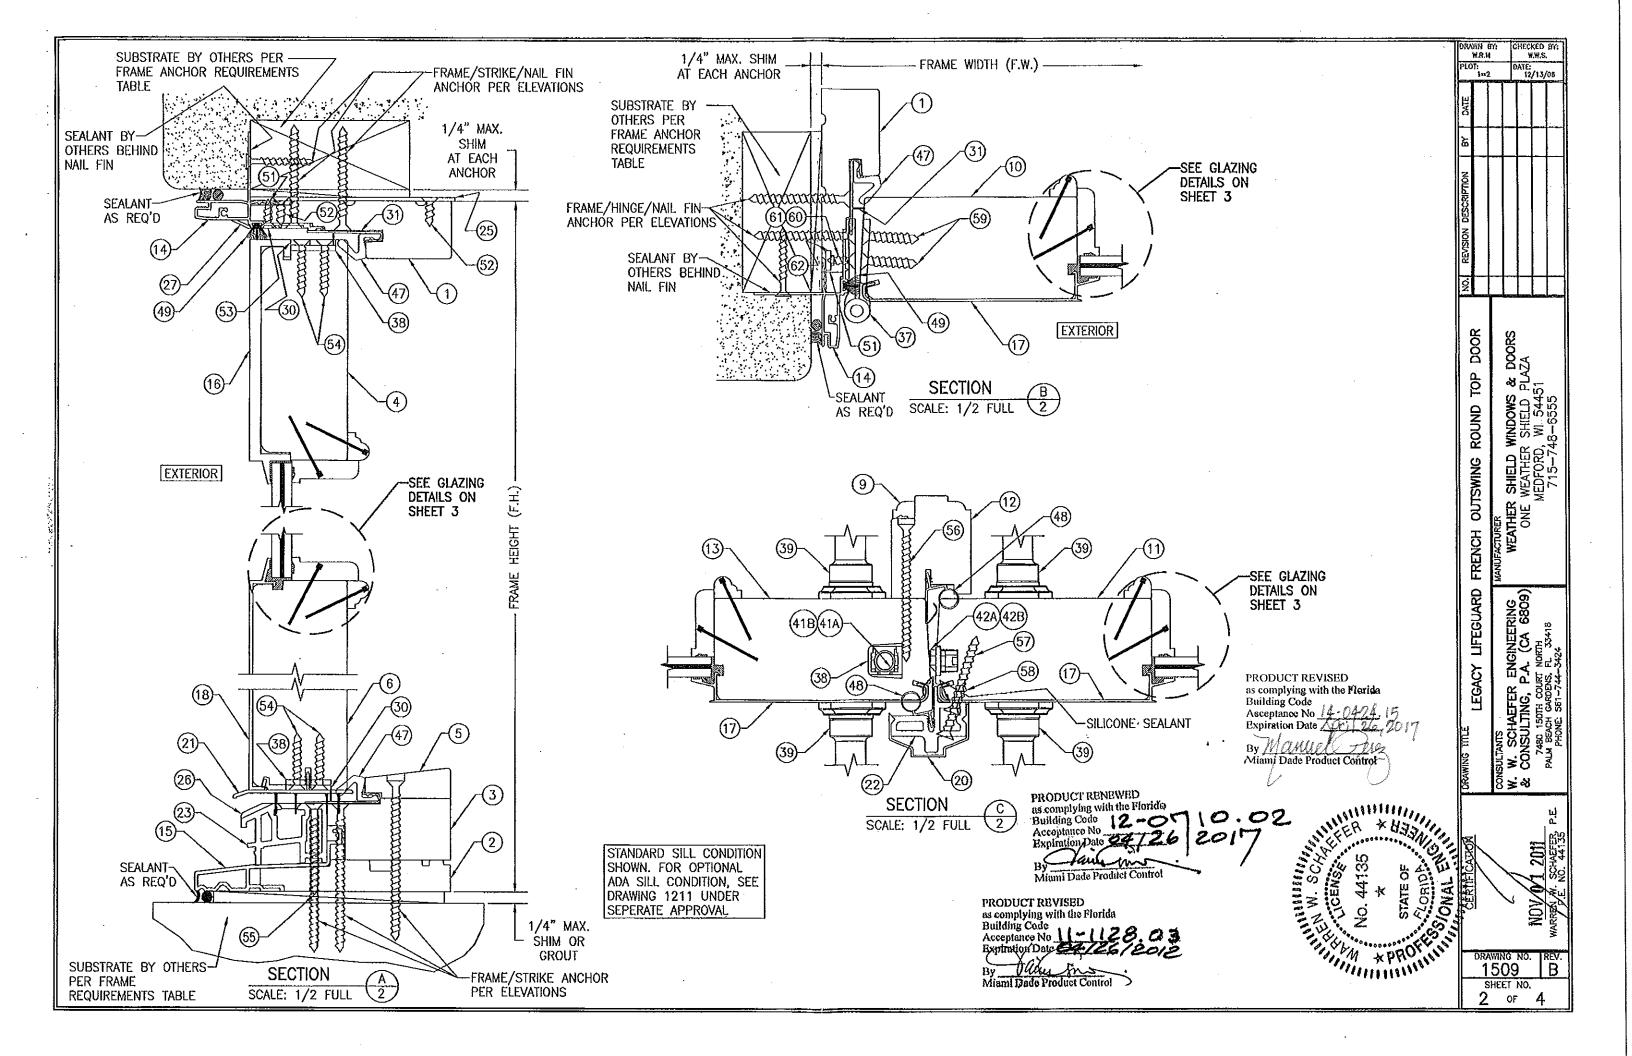

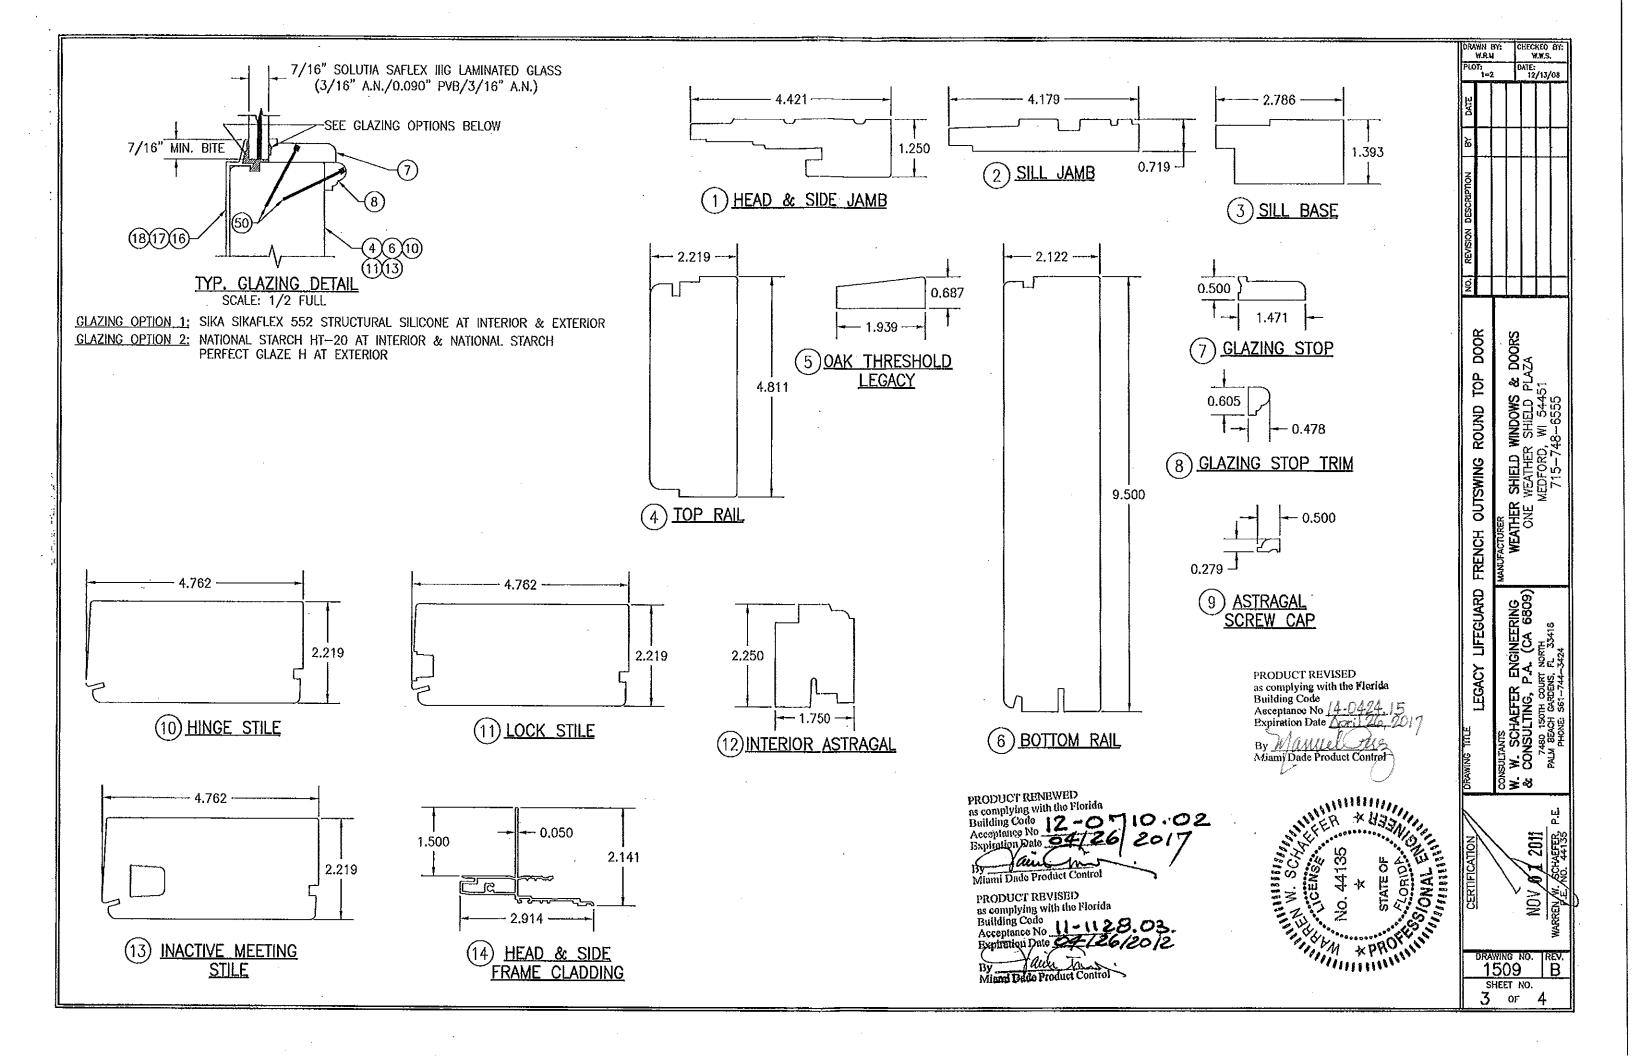

		1	
ITEM #	1	MANUFACTURER/NOTES	
	PARTS		
1	HEAD & SIDE JAMB	* WOOD -	
2	SILL JAMB	* WOOD	
3	SILL BASE	* WOOD	
4	TOP RAIL	* WOOD (PINE CORE BLOCK)	
5	OAK THRESHOLD LEGACY	OAK	
6	BOTTOM RAIL	* WOOD (PINE CORE BLOCK)	
7	GLAZING STOP	* WOOD	
8	GLAZING STOP TRIM	* WOOD	
9	ASTRAGAL SCREW CAP	* WOOD	
10	HINGE STILE	* WOOD (PINE WITH LVL CORE)	
11	LOCK STILE	* WOOD (PINE WITH LVL CORE)	
12	INTERIOR ASTRAGAL	* WOOD	
13	INACTIVE MEETING STILE	* WOOD (PINEWITH LVL CORE)	
	HEAD & SIDE FRAME CLADDING	6063-T5 OR 6063-T4 ALUMINUM	
15 16	SILL JAMB CLADDING TOP RAIL CLADDING		
17	STILE CLADDING	6063-T5 ALUMNUM	
18			
20	EXTERIOR ASTRAGAL COVER	6063-T5 ALUMINUM 6063-T5 ALUMINUM	
21	BOTTOM SWEEP	VINYL	
22	ASTRAGAL BASE	6063-T5 ALUMINUM	
23	THRESHOLD	VINYL	
24	GROMMET	PVC	
25	HEAD JAMB BACKER PLATE (10.125" X 4.50" X .080")	STAINLESS STEEL	
26	SILL STRIKE PLATE (4.000" X 2.817" X .125")	304 S.S.	
27	HEAD STRIKE PLATE (5.634" X 1.762" X .060")	304 S.S.	
28	TONGUE STIKE PLATE (5.000" X 1.000" X .059")	304 S.S.	
30	PANEL CORNER REINFORCEMENT BAR (10.100" X 1.000" X .120")	304 S.S 1 PER PANEL CORNER	
31	WEATHER STRIP CARRIER	VINYL	
	HARDWARE		
37	4 X 4 ADJUSTABLE HINGE	HOPPE	
-38	10 MM SHOOT BOLT GUIDE	NYLON 6, 30% GLASS FIBER	
39	HANDLE SET	AS REQUIRED TO OPERATE DOOR LOCKS	
-40A	2-POINT CONCEALED INACTIVE PANEL LOCK SET	HOPPE	
40B	2-POINT CONCEALED INACTIVE PANEL LOCK SET	ASHLAND XP45	
41A	.38 TOP & BOTTOM EXTENSION ROD CONCEALED	HOPPE NORTH AMERICA HLS SERIES	
·41B	.38 TOP & BOTTOM EXTENSION ROD CONCEALED	ASHLAND XP45	
42A	5-POINT ACTIVE PANEL LOCK ASSY, W/SHOOT BOLTS	HOPPE NORTH AMERICA HLS 9000 SERIES	
42B	42B 5-POINT ACTIVE PANEL LOCK ASSY. W/SHOOT BOLTS ASHLAND XP45		
SEALS & SEALANTS			
	HEAD, SILL & SIDE TFT WEATHERSTRIP	FOAM	
48	INTEK ARLOC WEATHERSTRIP	VINYL	
49	AMESBURY WEATHERSTRIP	PILE	
FASTENERS			
50	F16 X 1 1/2" BRAD NAIL	2" FROM ENDS & 12" MAX. O.C.	
	3/16" X 1/2' STAPLE	3" FROM ENDS & 20" MAX. O.C.	
	NO. 7 X 5/8" FH WOOD SCREW	8 PER HEAD JAMB BACKER PLATE	
53	NO. 7 X 5/8" FH WOOD SCREW	2 PER HEAD STRIKE PLATE	
54 55	NO. 8 X 1 1/4" WOOD SCREW	4 PER CORNER REINFORCEMENT PLATE	
. 55 . 56	NO. 8 X 1 1/2° FH SMS SCREW	2 PER STRIKE PLATE	
56	NO. 8 X 3° FH WOOD SCREW	2" FROM ASTRAGAL ENDS & 6" O.C.	
	NO. 8 X 2" FH DRYWALL SCREW	1 1/2" & 2 1/2" FROM PANEL ENDS	
58 59	NO. 8 X 1 1/4" WOOD SCREW NO. 8 X 1 1/4" WOOD SCREW	10" FROM ASTRAGAL ENDS & 8" O.C.	
	NO. 8 X 1 1/4 WOOD SCREW NO. 8 X 5/8" FH S.S. WOOD SCREW	4 PER HINGE	
60 61	NO. 8 × 5/8" FH S.S. WOOD SCREW	2 PER HINGE (BOTTOM 2 HINGES)	
	NO. 8-32 "T-NUT"	2 PER HINGE (TOP 2 HINGES) 2 PER HINGE (TOP 2 HINGES)	
* WOOD USED IN TESTING WAS WESTERN PINE. OTHER WOOD SPECIES APPLICABLE FOR USE WITH THIS PRODUCT			

^{*} WOOD USED IN TESTING WAS WESTERN PINE. OTHER WOOD SPECIES APPLICABLE FOR USE WITH THIS PRODUCT ARE THOSE WITH A SPECIFIC GRAVITY OF 0.43 AND MODULUS OF ELASTICITY OF 1,200,000 PSI OR GREATER, ALL WOOD IS MINIMUM GRADE 2 MILLED BY WEATHER SHIELD TO SELECT,

